# 23 - 25 CHARLES STREET, LIVERPOOL PROPOSED MULTI-UNIT DEVELOPMENT

STORMWATER CONCEPT PLANS



**LOCALITY PLAN** 

DRAWING INDEX					
Drawing No.	DESCRIPTION				
000	COVER SHEET PLAN				
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104	SEDIMENT & EROSION CONTROL PLAN				


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Dwg. No. 000

					Th	Idraft Architecs Pty Lt Unit 43,2 Slough Avenue,
^	ISSUE FOR DEVELOPMENT APPLICATION	09/12/2020	AGA	JSF	A. Millow	Silverwater NSW 2128
<u> </u>	ISSUE FOR DEVELOPMENT APPLICATION	09/12/2020	AGA	JOF	ADJI	PHONE : 02 9648 8848
Issue	Description	Date	Design	Checked	1 State 1	Email :pierre@idraft.com.au
10	m at full size			20cm	1 000	www.idraft.com.au

k	Council	Scale		AUSTRALIAN
Liverpool City Council			CONSULTING ENGINEERS.	
	City Courien		AUSTRALIAN	PTY LTD - A.C.N. 084 059 94
			CONSULTING	
			FNGINFERS	PH: (02) 9763 I500 FX: (02) 9763 I5I5




# **GENERAL NOTES**

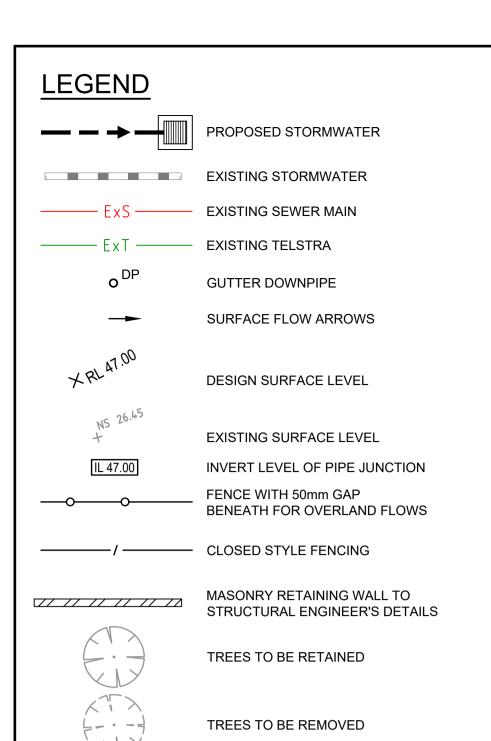- ALL LINES ARE TO BE Ø90 uPVC 1.0% GRADE UNLESS NOTED OTHERWISE. CHARGED LINES TO BE SEWERGRADE & SEALED.
- EXISTING SERVICES LOCATIONS SHOWN INDICATIVE ONLY. IT IS THE CONTRACTOR'S RESPONSIBILITY TO LOCATE & LEVEL ALL EXISTING SERVICES PRIOR TO THE
- 3. ALL PIPES TO HAVE MIN 150mm COVER IF LOCATED WITHIN PROPERTY.

COMMENCEMENT OF ANY EARTHWORKS.

- 4. ALL PITS IN DRIVEWAYS TO BE 450x450 CONCRETE AND ALL PITS IN LANDSCAPED AREAS TO BE 450x450 PLASTIC.
- 5. PITS LESS THAN 600mm DEEP MAY BE BRICK, PRECAST OR CONCRETE.
- 6. ALL BALCONIES AND ROOFS TO BE DRAINED AND TO HAVE SAFETY OVERFLOWS IN ACCORDANCE WITH RELEVANT AUSTRALIAN STANDARDS.
- 7. ALL EXTERNAL SLABS TO BE WATERPROOFED.
- 8. ALL GRATES TO HAVE CHILD PROOF LOCKS.
- 9. ALL DRAINAGE WORKS TO AVOID TREE ROOTS.
- 10. ALL DPs TO HAVE LEAF GUARDS.
- 11. ALL EXISTING LEVELS TO BE CONFIRMED BY BUILDER PRIOR TO CONSTRUCTION.
- 12. ALL WORK WITHIN COUNCIL RESERVE TO BE INSPECTED BY COUNCIL PRIOR TO CONSTRUCTION.
- 13. COUNCIL'S ISSUED FOOTWAY DESIGN LEVELS TO BE INCORPORATED INTO THE FINISHED LEVELS ONCE ISSUED BY COUNCIL.
- 14. ALL WORK SHALL BE IN ACCORDANCE WITH B.C.A. AND A.S.3500.3.
- 15. REFER TO LANDSCAPE ARCHITECT'S DRAWINGS FOR LANDSCAPING.
- 16. CARE TO BE TAKEN AROUND EXISTING SEWER. STRUCTURAL ADVIICE IS REQUIRED FOR SEWER PROTECTION AGAINST ADDITIONAL LOADING FROM NEW PITS, PIPES, RETAINING WALLS AND OSD BASIN WATER LEVELS.
- 17. ALL PIPES IN BALCONIES TO BE Ø65 uPVC
  CAST IN CONCRETE SLAB. CONTRACTOR TO PROVIDE
  A BREAK / OPEN VOID IN RAIL / BALLUSTRADE
  FOR STORMWATER EMERGENCY OVERFLOW.
  ALL ENCLOSED AREAS/PLANTER BOXES TO BE FITTED
  WITH FLOOR WASTES & DRAINED TO OSD
  DOWNPIPES TO BE CHECKED BY ARCHITECT &
  PLUMBER PRIOR TO CONSTRUCTION.

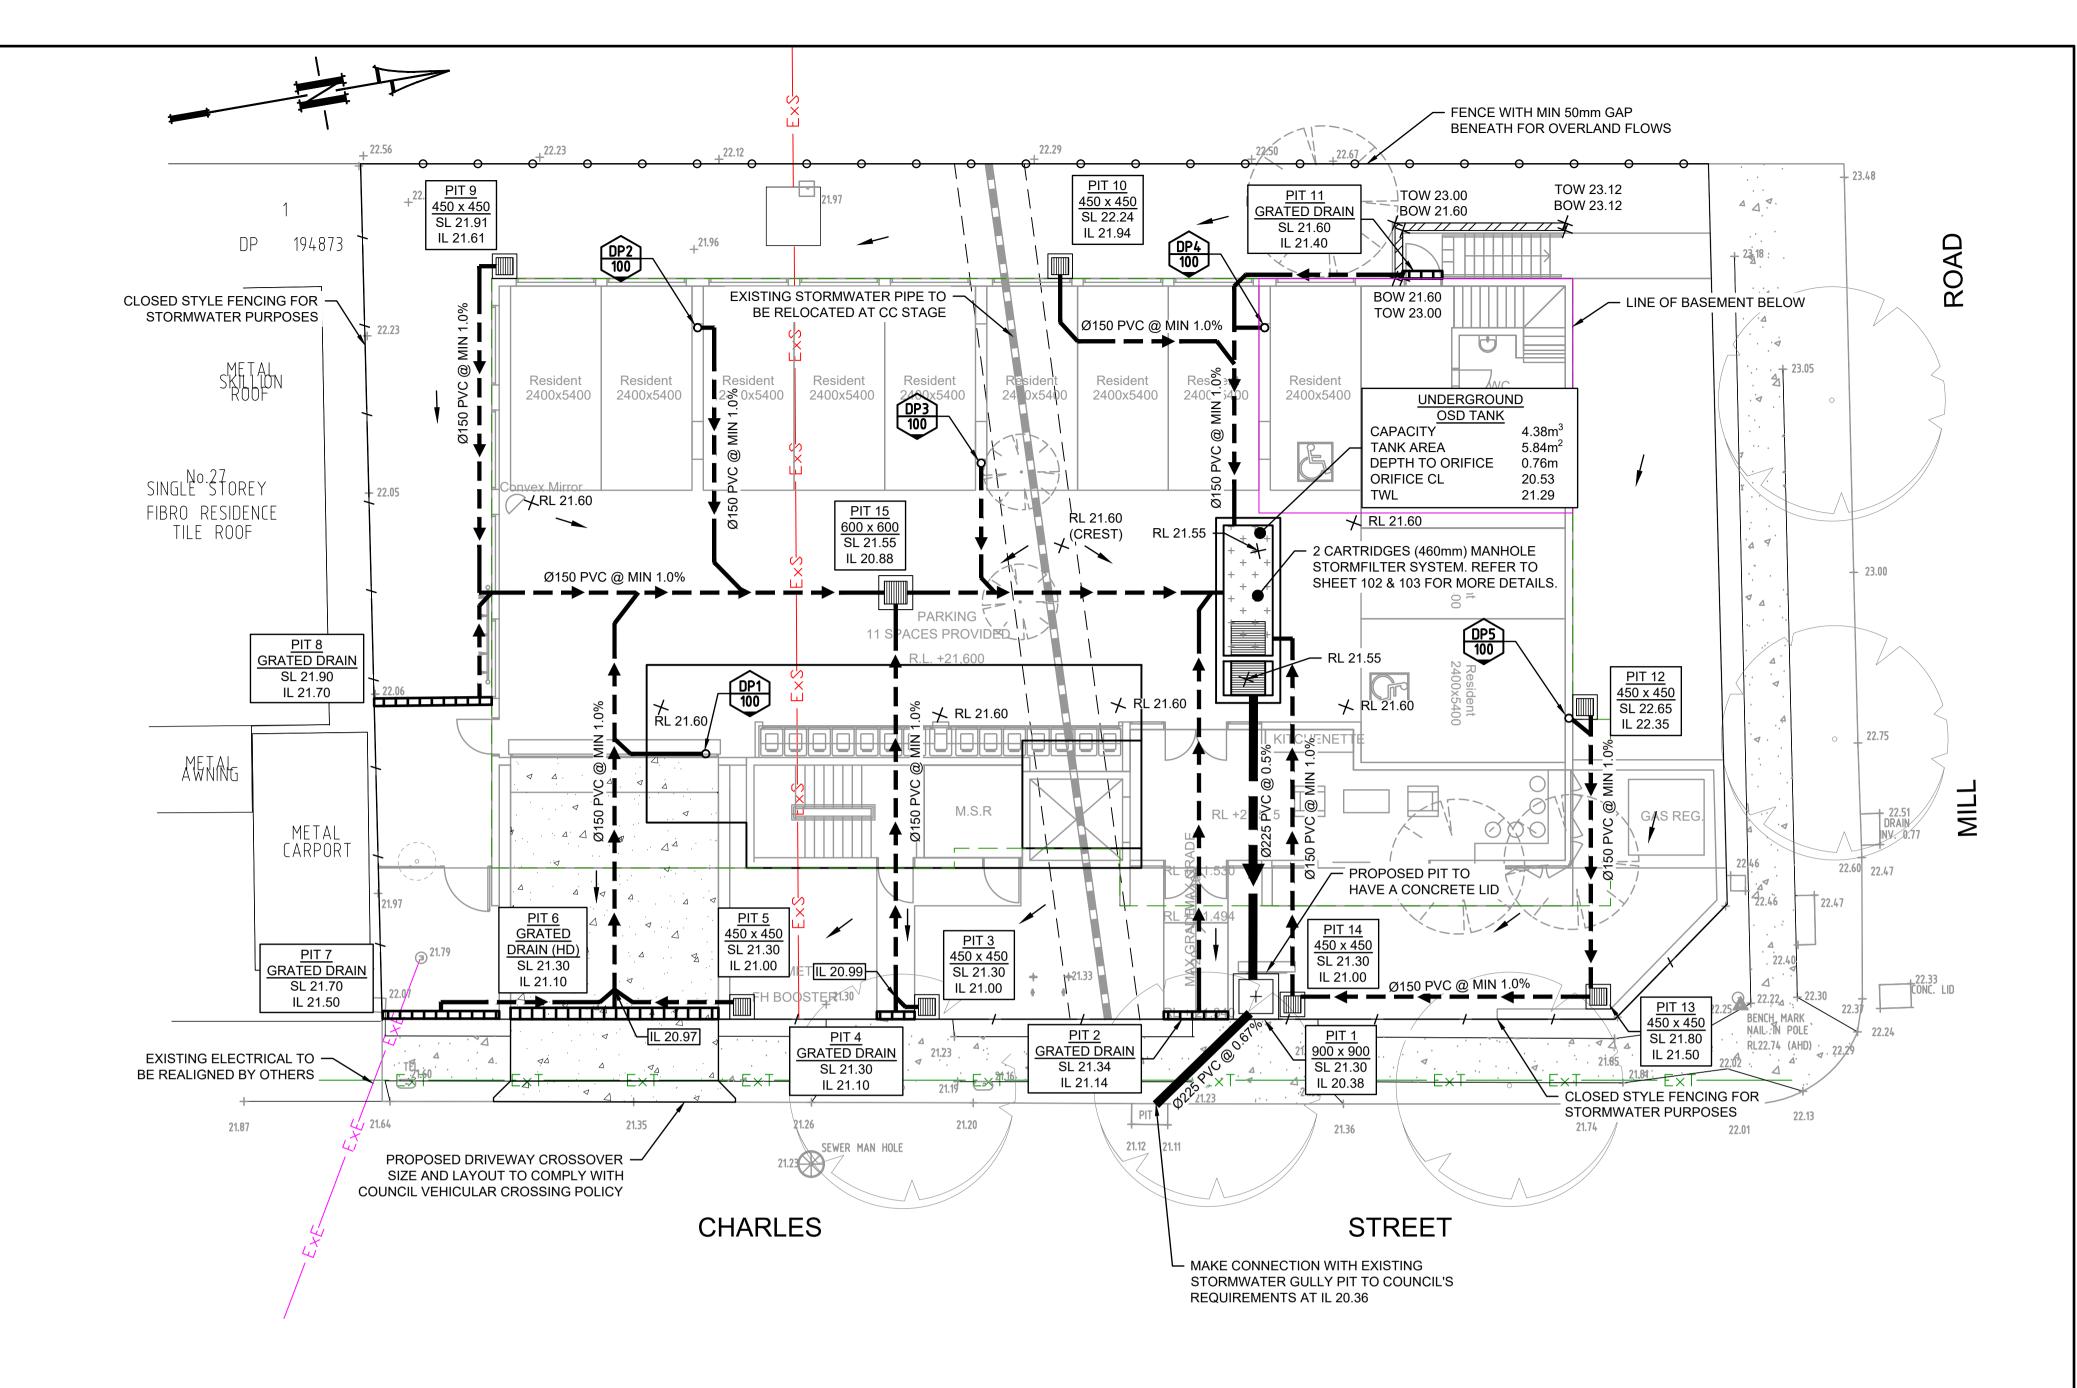

### PIPES NOTE:

Ø65 PVC @ MIN 1.0% Ø90 PVC @ MIN 1.0% Ø100 PVC @ MIN 1.0% Ø150 PVC @ MIN 1.0% Ø225 PVC @ MIN 0.5% Ø300 PVC @ MIN 0.4% UNLESS NOTED OTHERWISE

# **ROOF NOTE:**

IT IS CONTRACTOR'S RESPONSIBILITY TO ENSURE MINIMUM 30 TO 40MM OF PONDING IS ACHIEVED OVER THE RAINWATER OUTLETS BY GRADING CATCHMENTS' SURFACES AT MINIMUM 0.5% FALL FOR PAVED SURFACES AND MINIMUM 1% FALL FOR OTHER SURFACES.

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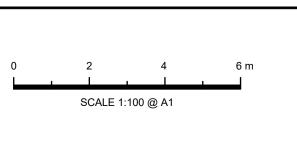
Certification By Dr. Anthony Hasham (NPER

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Liverpool City Counci






23 - 25 CHARLES STREET, LIVERPOOL PROPOSED MULTI-UNIT DEVELOPMENT STORMWATER CONCEPT PLANS DEVELOPMENT APPLICATION

STORMWATER CONCEPT PLAN

Scale A1 Project No. Dwg. No. 1:100 200977 101

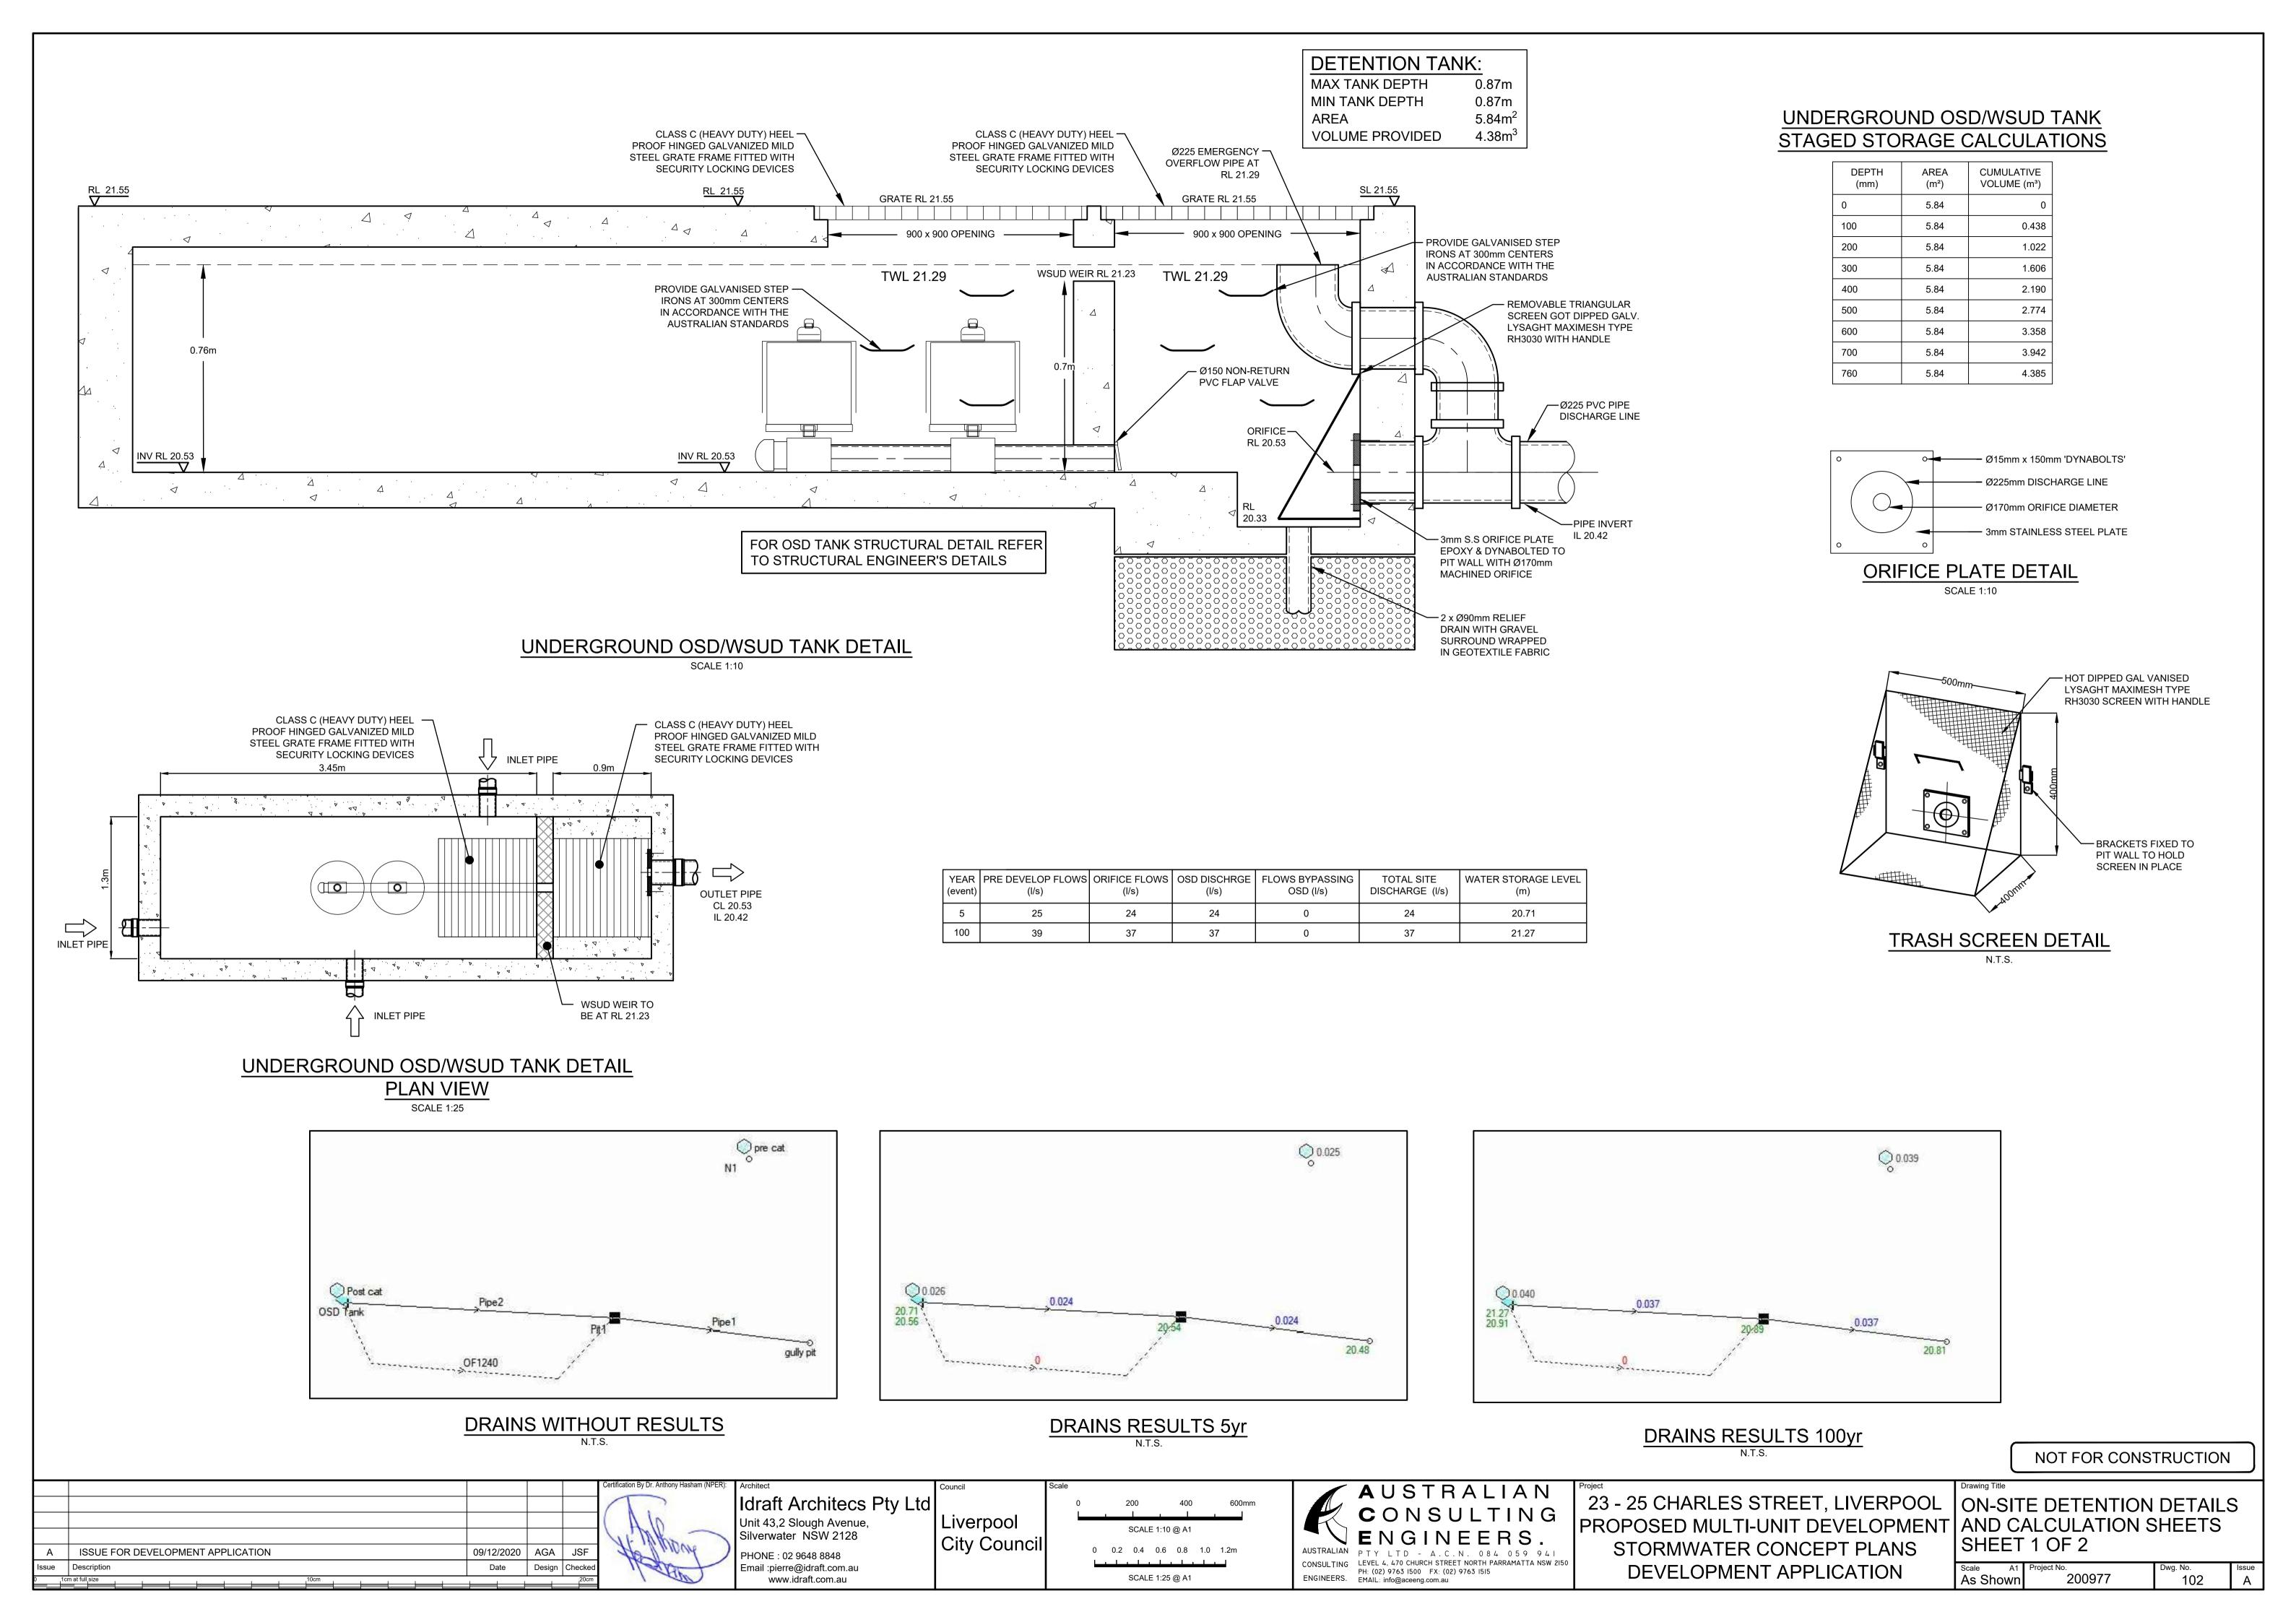

#### SITE SPECIFIC DATA REQUIREMENTS STRUCTURE ID WATER QUALITY FLOW RATE (L/S) PEAK FLOW RATE (L/S) RETURN PERIOD OF PEAK FLOW (yrs) # OF CARTRIDGES REQUIRED (8-22) CARTRIDGE HEIGHT (310, 460 or 690mm) 460 MEDIA TYPE (PERLITE, PERLITE/ZEOLITE OR ZPG) ZPG PRECAST VAULT WEIGHT 2524 kg PRECAST LID WEIGHT 547 kg DIAMETER PIPE DATA: MATERIAL 150 INLET PIPE #1 20.53 INLET PIPE #2 20.53 150 INLET PIPE #3 20.53 150 PVC OUTLET PIPE 20.42 PVC 225 PIPE ORIENTATION DOWNSTREAM UPSTREAM FLOW **FLOW** LADDER YES/NO ANTI-FLOTATION BALLAST N/A N/A N/A

# STORMFILTER TABLE

# **GENERAL NOTES**


- 1. INLET AND OUTLET PIPING SHALL BE SPECIFIED BY SITE CIVIL ENGINEER (SEE PLANS) AND PROVIDED BY CONTRACTOR. STORMFILTER IS PROVIDED WITH OPENINGS AT INLET AND OUTLET LOCATIONS.
- 2. IF THE PEAK FLOW RATE, AS DETERMINED BY THE SITE CIVIL ENGINEER, EXCEEDS THE PEAK HYDRAULIC CAPACITY OF THE PRODUCT, AN UPSTREAM BYPASS STRUCTURE IS REQUIRED. PLEASE CONTACT STORMWATER360 FOR OPTIONS.
- 3. THE FILTER CARTRIDGE(S) ARE SIPHON-ACTUATED AND SELF-CLEANING. THE STANDARD DETAIL DRAWING SHOWS THE MAXIMUM NUMBER OF CARTRIDGES. THE ACTUAL NUMBER SHALL BE SPECIFIED BY THE SITE CIVIL ENGINEER ON SITE PLANS OR IN DATA TABLE BELOW. PRECAST STRUCTURE TO BE CONSTRUCTED IN ACCORDANCE WITH AS3600.
- 4. FOR SHALLOW, LOW DROP OR SPECIAL DESIGN CONSTRAINTS, CONTACT STORMWATER360 FOR DESIGN OPTIONS.
- 5. ALL WATER QUALITY PRODUCTS REQUIRE PERIODIC MAINTENANCE AS OUTLINED IN THE O&M GUIDELINES. PROVIDE MINIMUM CLEARANCE FOR MAINTENANCE ACCESS.
- 6. STRUCTURE AND ACCESS COVERS DESIGNED TO MEET
- AUSTROADS T44 LOAD RATING WITH 0-2m FILL MAXIMUM. 7. THE STRUCTURE THICKNESSES SHOWN ARE FOR
- REPRESENTATIONAL PURPOSES AND VARY REGIONALLY. 8. ANY BACKFILL DEPTH, SUB-BASE, AND OR ANTI-FLOTATION PROVISIONS ARE SITE-SPECIFIC DESIGN CONSIDERATIONS AND
- SHALL BE SPECIFIED BY SITE CIVIL ENGINEER. 9.. STORMFILTER BY STORMWATER360: SYDNEY (AU) PHONE: (02) 9525 5833, BRISBANE (AU) PHONE: (07) 3272 1872.


## STORMFILTER DESIGN TABLE

- STORMFILTER TREATMENT CAPACITY VARIES BY NUMBER OF FILTER CARTRIDGES INSTALLED AND
- BY REGION SPECIFIC INTERNAL FLOW CONTROLS. CONVEYANCE CAPACITY IS RATED AT 80L/S. • THE STANDARD CONFIGURATION IS SHOWN. ACTUAL CONFIGURATION OF THE SPECIFIED
- STRUCTURE(S) PER CIVIL ENGINEER WILL BE SHOWN ON SUBMITTAL DRAWING(S).
- ALL PARTS PROVIDED AND INTERNAL ASSEMBLY BY STORMWATER360 AUSTRALIA UNLESS
- OTHERWISE NOTED.

CARTRIDGE HEIGHT	690		460		310	
SYSTEM HYDRAULIC DROP (H - REQ'D. MIN.)	930		700		550	
TREATMENT BY MEDIA SURFACE AREA L/S/m2	1.4	0.7	1.4	0.7	1.4	0.7
CARTRIDGE FLOW RATE (L/s)	1.42	0.71	0.95	0.47	0.63	0.32

SYSTEM HYDRAULIC DROP CARTRIDGE FLOW RATE

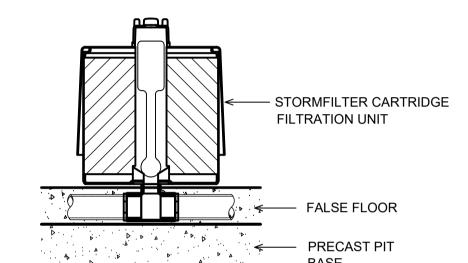

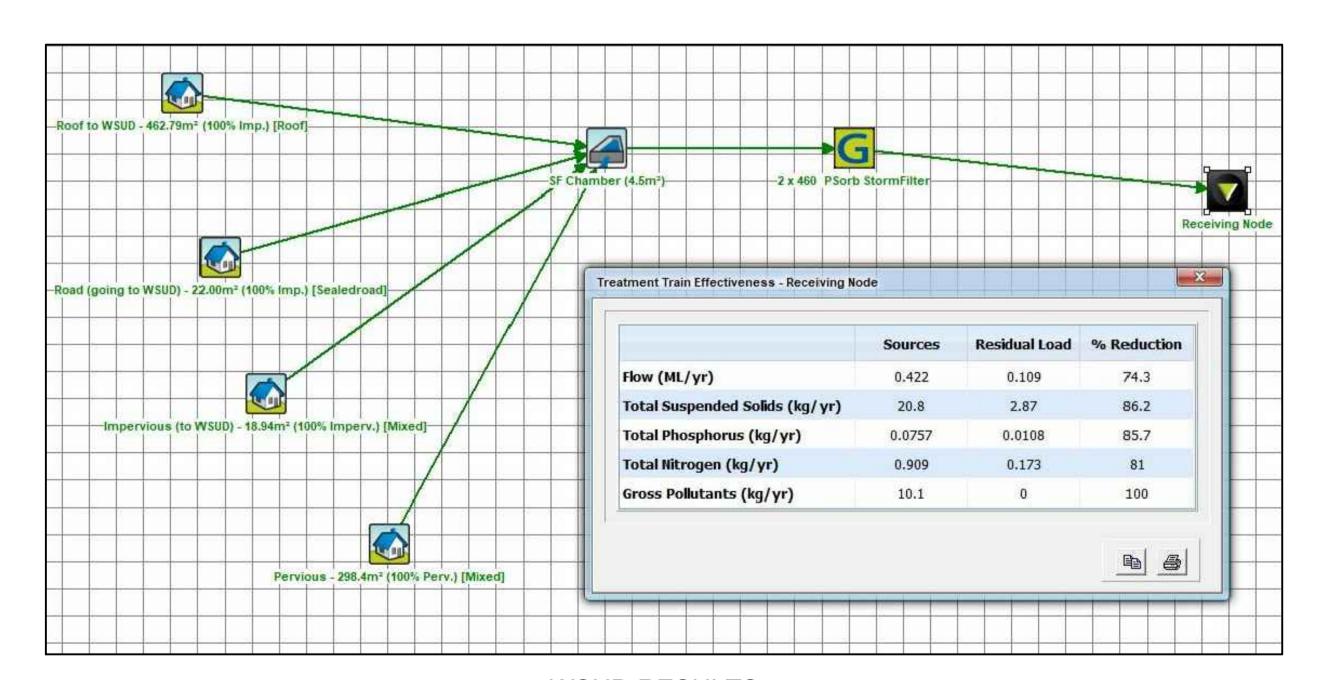

WSUD RESULTS

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					Certificat
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					1
Α	ISSUE FOR DEVELOPMENT APPLICATION	09/12/2020	AGA	JSF	7
ssue	Description	Date	Design	Checked	

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Liverpool City Council

200 400 SCALE 1:10 @ A1 0 0.2 0.4 0.6 0.8 1.0 1.2m SCALE 1:25 @ A1



23 - 25 CHARLES STREET, LIVERPOOL PROPOSED MULTI-UNIT DEVELOPMENT AND CALCULATION SHEETS STORMWATER CONCEPT PLANS DEVELOPMENT APPLICATION

ON-SITE DETENTION DETAILS SHEET 2 OF 2

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